

GENERAL NOTES

- THE SCOPE OF SITE WORK FOR THIS PROJECT INCLUDES PROTECTION OF EXISTING STRUCTURES AND UTILITIES, AND REINSTATEMENT OF DISBURSED AREAS OF THE SITE TO ORIGINAL CONDITIONS. THE CONTRACTOR SHALL BE RESPONSIBLE FOR OBTAINING ALL NECESSARY PERMITS AND APPROVALS FROM ALL APPLICABLE AGENCIES AND AGENCIES. THE CONTRACTOR SHALL REVIEW THE DRAWINGS AND SITE CONDITIONS PRIOR TO THE START OF WORK AND CONTACT THE PROJECT ARCHITECT IMMEDIATELY IF DISCREPANCIES ARE FOUND.
- UNDERGROUND UTILITIES HAVE BEEN LOCATED FROM HISTORICAL RECORDS AND FIELD SURVEY. THE CONTRACTOR SHALL BE RESPONSIBLE FOR VERIFYING THE LOCATION AND DEPTH OF ALL UTILITIES. THE CONTRACTOR SHALL BE RESPONSIBLE FOR OBTAINING ALL NECESSARY PERMITS AND APPROVALS FROM ALL APPLICABLE AGENCIES AND AGENCIES. THE CONTRACTOR SHALL REVIEW THE DRAWINGS AND SITE CONDITIONS PRIOR TO THE START OF WORK AND CONTACT THE PROJECT ARCHITECT IMMEDIATELY IF DISCREPANCIES ARE FOUND.
- ALL UTILITIES SHALL BE PROTECTED AND MAINTAINED THROUGHOUT THE CONSTRUCTION PERIOD. THE CONTRACTOR SHALL BE RESPONSIBLE FOR OBTAINING ALL NECESSARY PERMITS AND APPROVALS FROM ALL APPLICABLE AGENCIES AND AGENCIES. THE CONTRACTOR SHALL REVIEW THE DRAWINGS AND SITE CONDITIONS PRIOR TO THE START OF WORK AND CONTACT THE PROJECT ARCHITECT IMMEDIATELY IF DISCREPANCIES ARE FOUND.
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- ANY UTILITIES OR RECONSTRUCTION REQUIRED AS PART OF THE PROJECT SHALL BE COMPLETED PRIOR TO THE START OF CONSTRUCTION. THE CONTRACTOR SHALL BE RESPONSIBLE FOR OBTAINING ALL NECESSARY PERMITS AND APPROVALS FROM ALL APPLICABLE AGENCIES AND AGENCIES. THE CONTRACTOR SHALL REVIEW THE DRAWINGS AND SITE CONDITIONS PRIOR TO THE START OF WORK AND CONTACT THE PROJECT ARCHITECT IMMEDIATELY IF DISCREPANCIES ARE FOUND.
- TEMPORARY WORK SUPPORT AND PROTECTION OF STRUCTURES ARE THE RESPONSIBILITY OF THE CONTRACTOR AND THE COSTS SHALL BE CONSIDERED INCIDENTAL TO THE OVERALL PROJECT COST.
- ALL WORK SHALL BE UNDERWRITTEN IN STRICT ACCORDANCE WITH LOCAL, STATE AND FEDERAL SAFETY STANDARDS.
- OPERATION AND MAINTENANCE SHALL BE CLEARLY DEMONSTRATED AND FINISHED AS SHOWN ON THE DRAWINGS. THE CONTRACTOR SHALL BE RESPONSIBLE FOR OBTAINING ALL NECESSARY PERMITS AND APPROVALS FROM ALL APPLICABLE AGENCIES AND AGENCIES. THE CONTRACTOR SHALL REVIEW THE DRAWINGS AND SITE CONDITIONS PRIOR TO THE START OF WORK AND CONTACT THE PROJECT ARCHITECT IMMEDIATELY IF DISCREPANCIES ARE FOUND.
- OPERATIONS, MAINTENANCE AND EMERGENCY VEHICLES, AS NECESSARY TO MAINTAIN THE FUNCTION OF THE FACILITY, COOPERATE WITH ALL WORK OWNERS TO ENSURE THAT ADEQUATE ACCESS AND CIRCULATION IS MAINTAINED AT ALL TIMES.
- CONTRACTOR SHALL BE RESPONSIBLE FOR OBTAINING ALL NECESSARY PERMITS AND APPROVALS FROM ALL APPLICABLE AGENCIES AND AGENCIES. THE CONTRACTOR SHALL REVIEW THE DRAWINGS AND SITE CONDITIONS PRIOR TO THE START OF WORK AND CONTACT THE PROJECT ARCHITECT IMMEDIATELY IF DISCREPANCIES ARE FOUND.
- ALL DISTRIBUTED PAVEMENT AREAS, ROADS AND DRIVEWAYS SHALL BE RENOVATED TO MATCH EXISTING GRADING, MATERIALS AND DEPTHS.
- EXISTING PAVEMENT SHALL BE SAWCUT AT LEAST TWELVE INCHES BOUND MATERIAL AND REPAIRED WITH MATCHING MATERIAL. STAMPTHE LINE BETWEEN EXISTING SURFACE MATERIAL AND THE NEW PAVEMENT SHALL BE PROVIDED BETWEEN REPAIRS WORKS AND EXISTING PAVEMENT. ALL REPAIRED AREAS SHALL BE GRADED TO MATCH EXISTING GRADING TO ENSURE PROPER DRAINAGE.

GEOTEXTILE & EROSION BLANKET NOTES:

- EROSION CONTROL BLANKET FOR USE IN EROSION CONTROL AREAS SHALL BE NON-Biodegradable Double Netting Erosion Blanket with a Non-Chlorinated Fiber Matrix and Organic Jute Netting. Erosion Control Blanket for use in channels shall be Biodegradable Double Netting Erosion Blanket with a Non-Chlorinated Fiber Matrix and Organic Jute Netting. Erosion Control Blanket for use in channels shall be Biodegradable Double Netting Erosion Blanket with a Non-Chlorinated Fiber Matrix and Organic Jute Netting.
- PERMANENT TURF REINFORCEMENT MAT FOR UNBUILT TURF SLOPES AND EROSION CONTROL AREAS SHALL BE A PERMANENT TURF REINFORCEMENT MAT FOR UNBUILT TURF SLOPES AND EROSION CONTROL AREAS. THE MAT SHALL BE NORTH AMERICAN GREEN PASTURE PROOF, CONSTRUCTION JOBSITE SPEC, OR APPROVED EQUAL.
- GEOTEXTILE SEPARATION FABRIC SHALL BE A NONWOVEN GEOTEXTILE MANUFACTURED FOR USE IN SUBGRADE DRAINAGE APPLICATIONS. THE MATERIAL SHALL HAVE AN OPENING SIZE OF 50 US STANDARD SIEVE (PER ASTM D4751) AND SHALL BE 100% POLYPROPYLENE. THE FABRIC SHALL BE 100% POLYPROPYLENE. THE FABRIC SHALL BE 100% POLYPROPYLENE. THE FABRIC SHALL BE 100% POLYPROPYLENE.
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RIPRAP STONE NOTES:

- STONE FOR RIPRAP SHALL CONSIST OF SUBANGULAR FIELD STONE OF TYPICAL UNIFORM SIZE. THE STONE SHALL BE PLACED TO PROTECT EXPOSED SOIL SURFACES FROM EROSION. THE STONE SHALL BE PLACED TO PROTECT EXPOSED SOIL SURFACES FROM EROSION. THE STONE SHALL BE PLACED TO PROTECT EXPOSED SOIL SURFACES FROM EROSION.
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PLANTING NOTES:

- THE LANDSCAPE CONTRACTOR SHALL SURVEY AND INSTALL ALL PLANTS IN STRICT ACCORDANCE WITH THE DRAWINGS. THE CONTRACTOR SHALL BE RESPONSIBLE FOR OBTAINING ALL NECESSARY PERMITS AND APPROVALS FROM ALL APPLICABLE AGENCIES AND AGENCIES. THE CONTRACTOR SHALL REVIEW THE DRAWINGS AND SITE CONDITIONS PRIOR TO THE START OF WORK AND CONTACT THE PROJECT ARCHITECT IMMEDIATELY IF DISCREPANCIES ARE FOUND.
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GRADING NOTES:

- SOIL DISTURBANCE IS TO BE KEPT TO A MINIMUM AND ALL BERTERRED AREAS SHALL BE RESTORED TO ORIGINAL CONDITIONS. THE CONTRACTOR SHALL BE RESPONSIBLE FOR OBTAINING ALL NECESSARY PERMITS AND APPROVALS FROM ALL APPLICABLE AGENCIES AND AGENCIES. THE CONTRACTOR SHALL REVIEW THE DRAWINGS AND SITE CONDITIONS PRIOR TO THE START OF WORK AND CONTACT THE PROJECT ARCHITECT IMMEDIATELY IF DISCREPANCIES ARE FOUND.
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EMBANKMENT NOTES:

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PLANTING LEGEND

EXISTING	PROPOSED

SITE ABBREVIATIONS

ALT	ABBREVIATION
ALT	ALTERATIVE
BCC	BOTTOM OF CURB
BOW	BOTTOM OF WALL
OP	CENTERLINE
CLL	CONTRACT LINE
CCD	EXISTING CATCH BASIN
PFE	FINISHED FLOOR ELEVATION
GA	GAUGE
GC	GENERAL CONTRACTOR
HC	HANDICAPPED
HMA	HOT MIX ASPHALT
HP	RIGHT POINT
IP	INSIDE DIAMETER
LP	LOW POINT
LT	LEFT
MAX	MAXIMUM
MIL	MILLIMETERS
MISC.	MISCELLANEOUS
NSS	NEW STORM DRAIN LINES
NSD	NEW SANITARY SEWER LINES
NW	NEW WATER LINES
OC	ON CENTER
OD	OUTSIDE DIAMETER
R	RADIUS
RE	REFER TO
ROW	RIGHT-OF-WAY
RT	RIGHT
S	SLOPE
T.B	TOP BOTTOM
TOC	TOP OF CURB
TOW	TOP OF WALL
TP	TEST PIT
TPY	TYPICAL
US	UNDERGROUND
W	WITH
WD	WIDEN

ISSUED FOR PERMIT

REV	DESCRIPTION	DATE

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NORDIC AQUAFARMS
285 NORTHPORT AVENUE
BEEFSTAR, MAINE

SITE NOTES & LEGENDS

SHEET TITLE: _____
SCALE: 1" = 30'
PROJECT NUMBER: _____
DATE OF RECORD: _____
JOB CHIEF: _____
DRAWN BY: _____
DATE: _____

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CONSTRUCTION SHEETS: _____

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ANSOM Consulting Engineers and Scientists

WOODWARD CLARKE
 150 HIGHLAND STREET, BELFAST, MAINE 04910
 TEL: 207.338.7678
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NORDIC AQUAFARMS
 MULTIPHASE PROJECT
 STORMWATER PLAN -
 AREA A

SCALE: 1" = 30'
 PROJECT NO. 17-05022
 PROJECT MANAGER: JMB
 DRAWN BY: JMB

CQ-101
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1700 BROAD ST. SUITE 200
 WOODBRIDGE, NJ 07095
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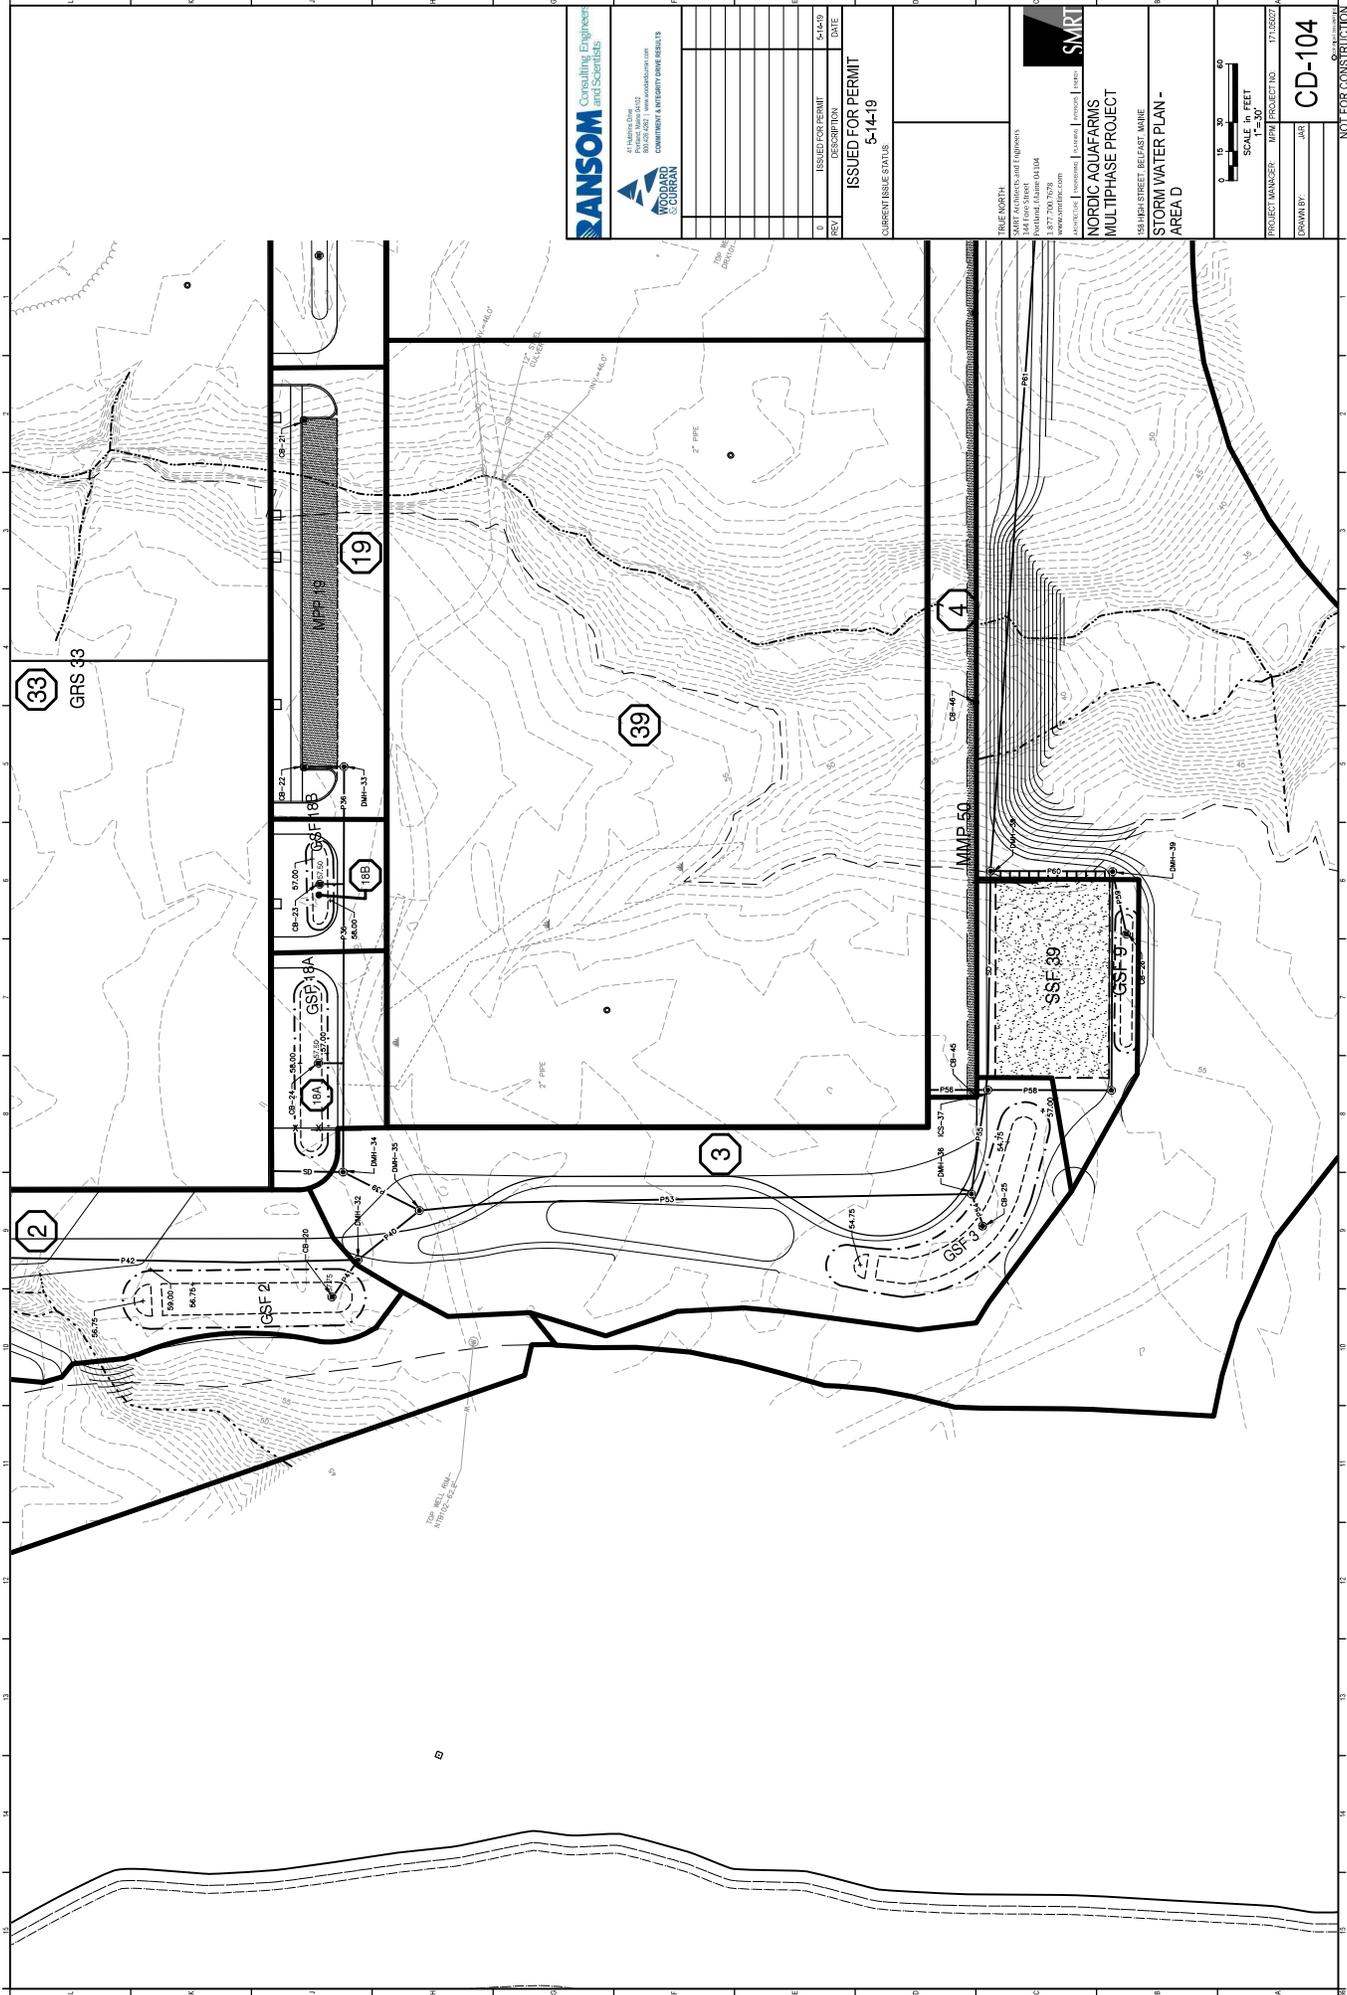
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 NORDIC AQUAFARMS
 MULTIPHASE PROJECT
 STORM WATER PLAN -
 AREA B

SCALE: 1" = 30'
 PROJECT NO. 17-05022
 PROJECT MANAGER: JMS
 DRAWN BY: JMS

CD-102

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 MULTIPHASE PROJECT
 STORM WATER PLAN -
 AREA D

SCALE: 1" = 30'
 PROJECT NO. 17-05027
 PROJECT MANAGER: JEN
 DRAWN BY: JAR

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CURRENT ISSUE STATUS

TRUE NORTH

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SMART
NORDIC AQUAFARMS
MULTIPHASE PROJECT

STORM WATER PLAN -
AREA E

SCALE: 1" = 30'
PROJECT NO. 17-05027

PROJECT MANAGER: JAR
DRAWN BY: JAR
CD-105

NOT FOR CONSTRUCTION

